

TO: CDOTPRC

FROM: Katriina S. McGuire

Thompson Coburn LLP

DATE: March 28, 2024

RE: 1630 South Wabash Avenue (the "Property")

Travel Demand Management Memo

The Property is proposed to be developed with a mixed-use development consisting of 149 dwelling units, 2,250 s.f. of ground floor commercial space, 49 accessory parking spaces, one 10ft. x 25ft. loading berth and 150 bicycle parking spaces (the "Project"). Parking and loading are accessed from S. Wabash Avenue since there is no alley access at the rear (CTA elevated tracks). The Project consists of 30% efficiency units and 70% dwelling units, with an overall average of 776 s.f. per unit.

The Project was initially permitted with 97 parking spaces and accordingly included an additional floor for parking. Upon the enactment of the Connected Communities Ordinance, the Project is now a Transit Served Location and has been revised to reduce the parking by half, to the current 49 parking spaces.

Travel Demand Management Strategies:

- By reducing the parking by half, the Project is consistent with the City's goals of minimizing singleoccupancy vehicle trips and vehicular trips overall.
- Bicycle parking has been increased to 1:1 with bicycle racks in close proximity to the garage entry from the building lobby. Specifications for the bicycle racks are included with this memo.
- Bicycle repair station is being provided.
- Vehicular parking spaces are not included in the rent of the units.
- Tenants will be provided with "welcome kits" outlining the bicycle parking, transit and walkability
 options of the neighborhood.

STRETCH RACK

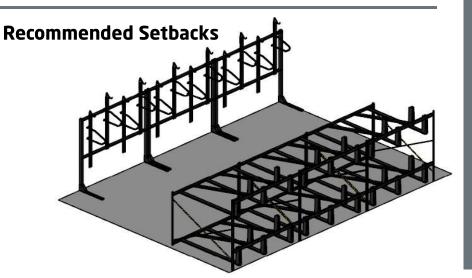


The stretch rack provides the most dense bike parking solution. The two tier design minimizes footprint, and the space saving vertical stagger further maximizes bike density. Available in locking and non-locking options, the stretch rack is a versatile, modular indoor solution for long term parking needs.

Product Specifications

- Modular construction allows for easy expansion, side by side or back to back
- Staggered bike position saves space and eases clearance between bikes
- Can be combined with vertical racks for full bike room layout
- Does not require anchoring (wall or floor)
- Bolt together design

Stretch Rack





Single Sided. 6 or 8-Bike Double Sided.







Freestanding Unit

Anchors must be purchased separately

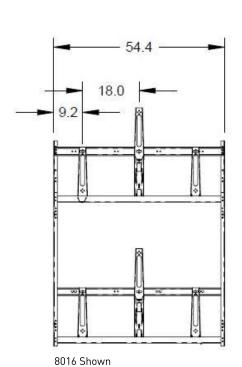


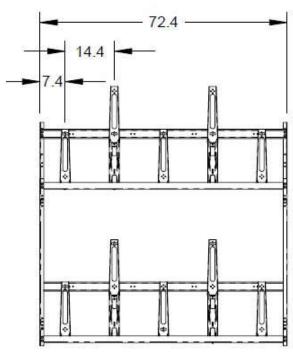
clearance required





the USA





8010	Shov

Dimensions										
Model #	# Bikes	Bike Spcaing	Ceiling Height Min.	Foot Print						
	Non-Locking									
8016	6	18"	96"	54" x 63"						
8018	8	13.5"	96"	54" x 63"						
8080	8	18"	96"	72" x 63"						
8010	10	14.4"	96"	72" x 63"						
		Locking	9							
8116	6	18"	96"	54" x 63"						
8118	8	13.5"	96"	54" x 63"						
8180	8	18"	96"	72" x 63"						
8110	10	14.4"	96"	72" x 63"						

Our Saris Infrastructure representatives can assist with custom layout and spacing to meet your room dimensions and desired bike capacity.

Downloadable product resources available online:









Saris Infrastructure



SECTION 02871

BICYCLE RACKS

Display hidden notes to specifier by using "Tools"/"Options"/"View"/"Hidden Text".

PART 1 GENERAL

1.1 SECTION INCLUDES

A. High capacity bicycle racks

Stretch Rack

Vertical Rack

1.2 RELATED SECTIONS

A. Section 02871 – Bicycle Racks: Installation location and coordination.

1.3 REFERENCES

- A. American Society for Testing and Materials ASTM A513 Standard Specification for Electric-Resistance-Welded Carbon and Alloy Steel Mechanical Tubing.
- B. American Society for Testing and Materials ASTM A500B Standard Specification for Cold-Formed Welded and Seamless Carbon Steel Structural Tubing in Rounds and Shapes.

1.4 SUBMITTALS

- A. Submit under provisions of Section 01300.
- B. [[Product Data]]: Manufacturer's data sheets on each product to be used, including:
 - 1. Preparation instructions and recommendations.
 - 2. Storage and handling requirements and recommendations.
- C. Shop Drawings: Manufacturing details for each bicycle rack.
- D. Selection Samples: For each finish product specified, two complete sets of color chips representing manufacturer's full range of available colors and patterns.
- E. Verification Samples: For each finish product specified, two samples, minimum size 6 inches (150 mm) square representing actual product, color, and patterns.

1.5 QUALITY ASSURANCE

A. Manufacturer Qualifications:

1. A firm experienced in manufacturing bicycle racks similar to those required for this project and with a record of successful in-service performance.

B. Installer Qualifications:

- An experienced installer who has completed installation of bicycle racks similar in material, design, and extent to that indicated for this project and whose work has resulted in construction with a record of successful in-service performance.
- C. Source Limitations: Obtain each color, finish, shape and type of bicycle rack from a single source with resources to provide components of consistent quality in appearance and physical properties.
- D. Mock-Up: Provide a mock-up for evaluation of surface preparation techniques and application workmanship.
 - 1. Install in areas designated by Architect.
 - 2. Do not proceed with remaining work until workmanship and installation are approved by Architect.
 - 3. Refinish mock-up area as required to produce acceptable work.

1.6 DELIVERY, STORAGE, AND HANDLING

- A. Store products in manufacturer's unopened packaging until ready for installation.
- B. Store and dispose of solvent-based materials, and materials used with solvent-based materials, in accordance with requirements of local authorities having jurisdiction.

1.7 PROJECT CONDITIONS

A. Maintain environmental conditions (temperature, humidity, and ventilation) within limits recommended by manufacturer for optimum results. Do not install products under environmental conditions outside manufacturer's absolute limits.

PART 2 PRODUCTS

2.1 MANUFACTURERS

- A. Acceptable Manufacturer: Saris Cycling Group; 5253 Verona Rd., Madison, WI 53711. ASD. Toll Free TEL: (800) 783-7257. Te1: (608) 274-6550.
 Fax: (608) 274-1702. Email: info@sarisinfrastructure.com
 Web: http://www.sarisinfrastructure.com
- B. Substitutions: Not permitted.
- Requests for substitutions will be considered in accordance with provisions of Section 01600.

2.2 HIGH CAPACITY BICYCLE RACKS

- A. Stretch Series: (items #8010; #8016; #8018; #8080; #8110; #8116; #8118; #8180)
 - 1. Construction: 11 gauge (0.06 inch) (1.52 mm) steel for corner pieces and cross braces.
 - 2. Capacity: 6 bike capacity, 18 inch (457 mm) spacing.
 - 3. Capacity: 8 bike capacity, 13.5 inch (343 mm) spacing.
 - 4. Capacity: 8 bike capacity, 18 inch (457 mm) spacing.
 - 5. Capacity: 10 bike capacity 14.4 inch (366 mm) spacing.

- 6. Locking Bar: 3/8 inch (9.5 mm) solid steel locking bar.
- 7. Finish: Polyester powder coat.
- 8. Color: Black.
- B. Vertical Series: (items #8023; #8024; #8043; #8044; #8033; #8034; #8063; #8064)
 - 1. Construction: 11 gauge (0.06 inch) (1.52 mm) steel for corner pieces and cross braces.
 - 2. Capacity: 3, 4, 5 bike capacity for single sided racks; 6, 8, 10 bike capacity for double sided racks
 - 3. Standard bike spacing: 18" between bikes for 3, 4 bike single sided racks, and 6, 8 double sided racks; 15" between bikes for 5 bike single sided rack and 10 bike double sided rack
 - 4. Locking Bar: 3/8 inch (9.5 mm) solid steel locking loop.
 - 5. Mount: Floor mount anchors recommended for single sided racks and REQUIRED for double sided racks.
 - 6. Finish: Polyester powder coat.
 - 7. Color: Black.

2.3 MATERIALS

2.4 FINISH

A. Manufacturer's standard factory-applied polyester paint finishes using a powder coating heat-cured system. Color as approved.

PART 3 EXECUTION

3.1 EXAMINATION

- A. Do not begin installation until substrates have been properly prepared.
- B. If substrate preparation is the responsibility of another installer, notify Architect of unsatisfactory preparation before proceeding.

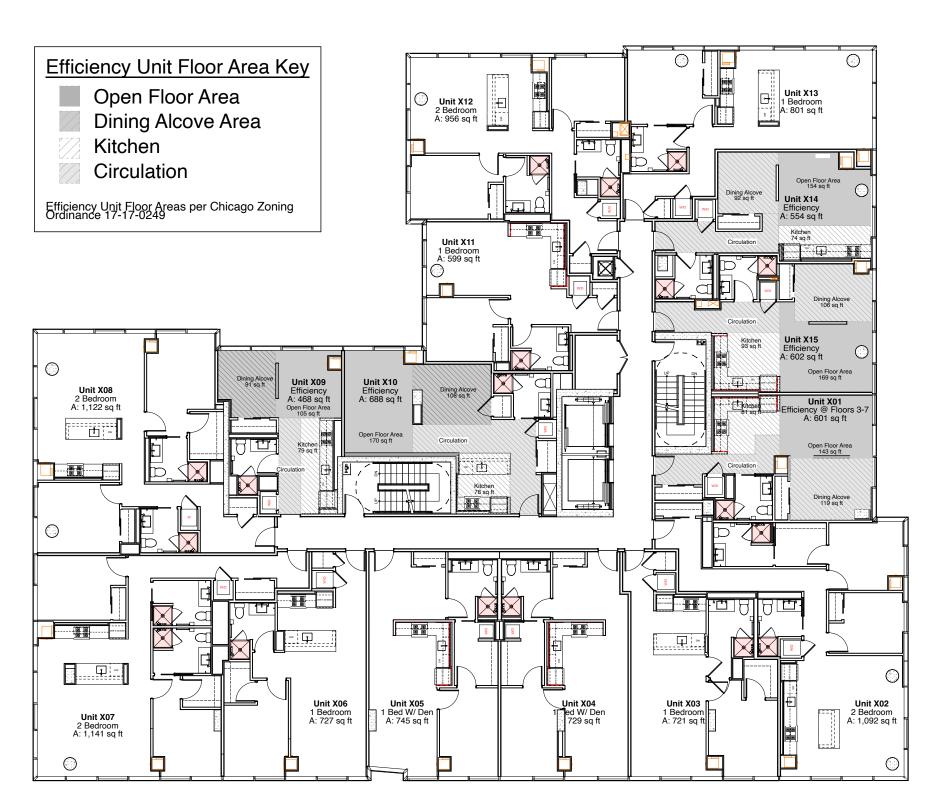
3.2 INSTALLATION

A. Install in accordance with manufacturer's instructions.

3.3 PROTECTION

- A. Protect installed products until completion of project.
- B. Touch-up, repair or replace damaged products before Substantial Completion.

END OF SECTION



Typical Floor - Efficiency Units Diagram

New Construction 2021	Chgo Landmark	Υ	N	Violations	Υ	N		
CHICAGO BUILDING CODE 14B	Lakefront Protection Distr.		7	ACAR Submitted		J		
Appl #:	Located in Flood Plain		J	Condominium				
	Permit Revision	J		Previous Permit Number			100986788	
Address:	4COO Coudh Wahaah A							
Address.	1630 South Wabash Av	enue						
Description of Work (Bldg Use, # of Stories, # DU's, parking proposed, nature of work and extent.	2019 CBC: Direct Developer Services: Revision to Full Building Permit #100986788 for a new 12 Story, 149 D.U. Residential Apartment Building with on Grade Parking (49 Parking Spaces) and Associated Site Work as Per Plans.							

	CLASSIFICATION BY OCCUPANCY USE GROUP (CBC 14B Chapter 3)									
A-3	Group A - Assembly	Group F - Factory	√	Group M - Mercanitile		Group U - Utility				
1	Group B - Business	Group H - High Hazard	R-2	Group R - Residential						
	Group E - Educational	Group I - Institutional	S-2	Group S- Storage						

PERMIT CATEGORY									
	Kind								Remarks
New Construction CBC 14B	New Construction	New Multi-f	amily buildir	ng - High Rise	, Concrete	structure full	y sprinklered	d	
Electrical	New Service								
		Work Area	Pescriptive Method	Performance Method	Historic Building	Tuckpointing	Re-roofing	Interior Non- Struct Demo	
	Violations Corrections								
	Repairs								
Eviation Duildings	Alterations L1								
Existing Buildings CRBC14R	Alterations L2								
	Alterations L3								
	Change of Occupancy								
	Addition								
	Relocated Buildings								

	BUILDING INFORMATION (CBC 14B)										
	No.						Е	Building Dimensio	ns		
	Sprinkler Protected Y/N	Constr Class CBC 14B-6-602	No. Stories	Basements	No. D.U.	Commercial Units	Width	Length	Height (CBC 14B)	Bldg Area (sf)	Work Area
Principal Building	Y	1A	12	0	149	1	116'-0"	146'-0"	130'-0"	132,741	132,741
Accessory Building	N	-	-	-	-	-	-	-	-	-	-
Detached Garage	N	-	-	-			-	-	-	-	-
Fence	N	-							-	-	
Exterior Trash Encl	N	-						-	-	-	

	ZONING INFORMATION (CZO 2023)										
Zoning District / PD #	DX-5	Front Setback	None								
Existing Zoning Use(s)	Vacant Apartments	Combined Side Setbacks	40' at Residential Floors								
Proposed Zoning Use(s)	Residential Apartments	Rear Setback	30' at Residential Floors								
Actual Parcel Information	27,058 sf or 0.62 ac	Rear Yard / On-site Open Space	5,364 Req 5,707 Provided								
Actual Parcel Existing	27,058 sf or 0.62 ac	Number of Dwelling Units	149								
Actual Required per CZO	27,058 sf or 0.62 ac	Number of Efficiency Units (include above)	44								
Actual Proposed	27,058 sf or 0.62 ac	Number of Off-street Parking Spaces	49 (incl 2 HC) (eTOD parking reduction)								
Chicago Landmark Designation	N/A	EVSE-ready Parking Spaces (include above)	10								
Lakefront Protection District	N/A	Number of Off-Street Loading Spaces	1 @ 10ft x 25ft								
Zoning Overlay District	N/A	Landscape Ordinance Compliance	Provided								
Pedestrian Street	N/A	Townhouse Development Standards	N/A								
Lot Area	27,058 sf or 0.62 ac	Planned Development Standards	N/A								
Floor Area Ratio (FAR)	135,213 sf	Open Space Impact Fee Worksheet	Provided								
Total Floor Area	140,222 sf	Affordable Requirements Ordinance (ARO) Forms	N/A								
Building Height (Under Roof)	129'-10" (12th Floor Ceiling)	Plat of Survey	Provided								
Front Setback	None										


1630 S. Wabash - Building Matrix Revised 11/10/2023


PROGRAM	SECTION	DIAGRAM			1630 S.	Wabash														
NTS				Use	Levels	Floor to Floor	Overall Height	Units/ Flr	Res Firs	Parking Spaces	Parking Lot Area	B.O.H Services/ Mech.	Lobby/ Common	Amenity	Retail	NSF / FL.	GSF / FL.	EFF / Flr	Avg Unit Size	FAR AREA
						FT	FT				SF	SF	SF	SF	SF	SF	SF		SF	SF
							130.0													
	Mech	anical	Amenity	Amenity	12	11.67	118.3	0	11				950	2,766			3,716	0.00		3,716
		Residential		Res	11	12.83	105.5	14	10			105	1,079			11,320	12,504	0.91	809	12,504
		Residential		Res	10	9.67	95.8	15	9			105	1,079			11,589	12,773	0.91	773	12,773
		Residential		Res	9	9.67	86.2	15	8			105	1,079			11,589	12,773	0.91	773	12,773
		Residential		Res	8	9.67	76.5	15	7			105	1,079			11,594	12,759	0.91	773	12,759
		Residential		Res	7	9.67	66.8	15	6			105	1,079			11,594	12,759	0.91	773	12,759
		Residential		Res	6	9.67	57.2	15	5			105	1,079			11,594	12,759	0.91	773	12,759
		Residential		Res	5	9.67	47.5	15	4			105	1,079			11,589	12,773	0.91	773	12,773
		Residential		Res	4	9.67	37.8	15	3			105	1,079			11,589	12,773	0.91	773	12,773
		Residential		Res	3	9.67	28.2	15	2			105	1,079			11,589	12,773	0.91	773	12,773
		Residential		Res	2	10.67	17.50	15	1			105	1,079			11,587	12,771	0.91	772	12,771
Parking I	Lot	Lobby	/ / B.O.H.	Ground	1	17.50	0.00			49	17,055	5,061	1,795		2,293		9,149			4,088
					Floors			Units		Parking Spaces *	Parking Lot Area	B.O.H Services/ Mech	Lobby/ Common	Amenity	Retail	NSF	GSF			
				Totals	12			149		49	17,055	6,111	13,535	2,766	2,293	115,634	140,282		776	135,221

1630 S. Wabash - Unit Mix								
Unit Types	Avg. Unit Sqft	Quantity	% of Total					
Efficiency- 1 Bath	568	44	29.53%					
1 Bed- 1 bath	724	37	24.83%					
1 Bed- 1 Bath + Den	700	29	19.46%					
2 Bed- 2 bath	1,026	39	26.17%					
Total	776	149	100.00%					

Required Parking	100 (1 space per DU) + 49 (0.60 per DU) = (129.4) 130 parking spaces				
Provided Parking	49 parking spaces*				
* 17-10-0102-D Small Dwelling Units.	Project seeking 25% reduction (33 parking scapes) parking ratio per Zoning Administrator approval. Building contains 149 Dwelling Units with an average unit size of 776 sqft.				
* 17-10-0102-B Transit-Served Locations Project seeking 50% reduction parking (49 parking spaces) based on Transit Served Location. Project is located 2147.52' from CTA (Cermak-McCormick Place) rail station entrance/exit. See Survey with distance to CTA station provided.					
Bike Parking Requirements					
Required Bike Parking	149 (1 bike per DU) = 149 parking spaces. (17-10-0102-B (2))				
Provided Bike Parking	150				

	Site Area:	27,058 sqft
	Zoning DX-5	FAR = 5
	Max FAR Area Allowed	135,290 sqft
	FAR Proposed	135,221 sqft
g e unit	Open Space	
	Open Scape Req.	5,364 sqft
ısit-	Open Scape Provided	5,707 sqft
		-

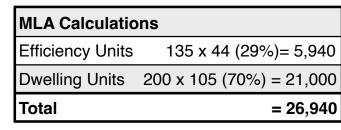

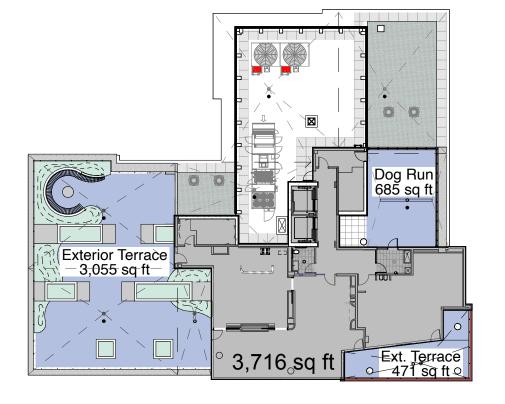



_12,504 sq

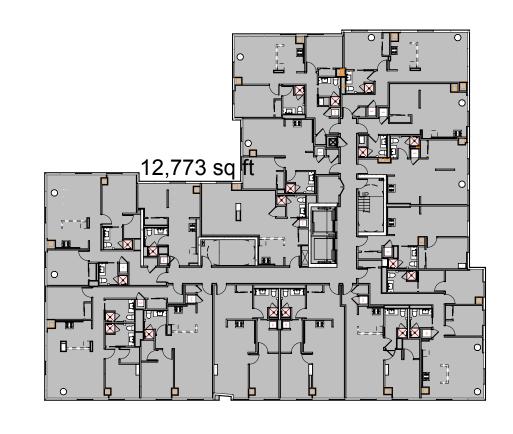
11th Floor Plan

SCALE: 1" = 30'




FAR Area: 12,504 sqft Open Space: N/A






3rd-5th, 9th-10th Floor Plan SCALE: 1" = 30'

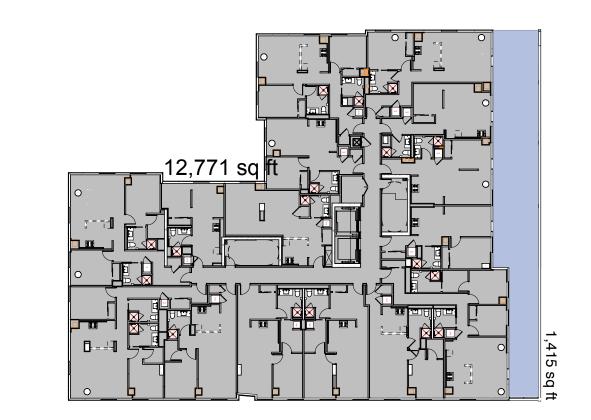FAR Area: 12,773 sqft Open Space: N/A sqft



2nd Floor Plan	
SCALE: 1" = 30'	

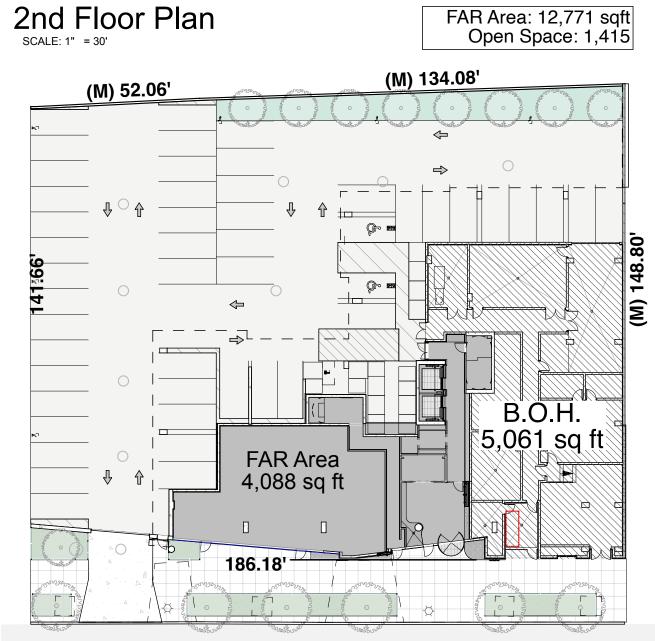

FAR Area: 4,088 sqft Open Space: N/A

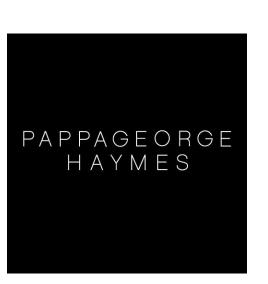
1st Floor Plan
SCALE: 1" = 30'

640 N Lasalle 312 337 3344 Architecture Suite 400 Urban Planning

Chicago Illinois 60654

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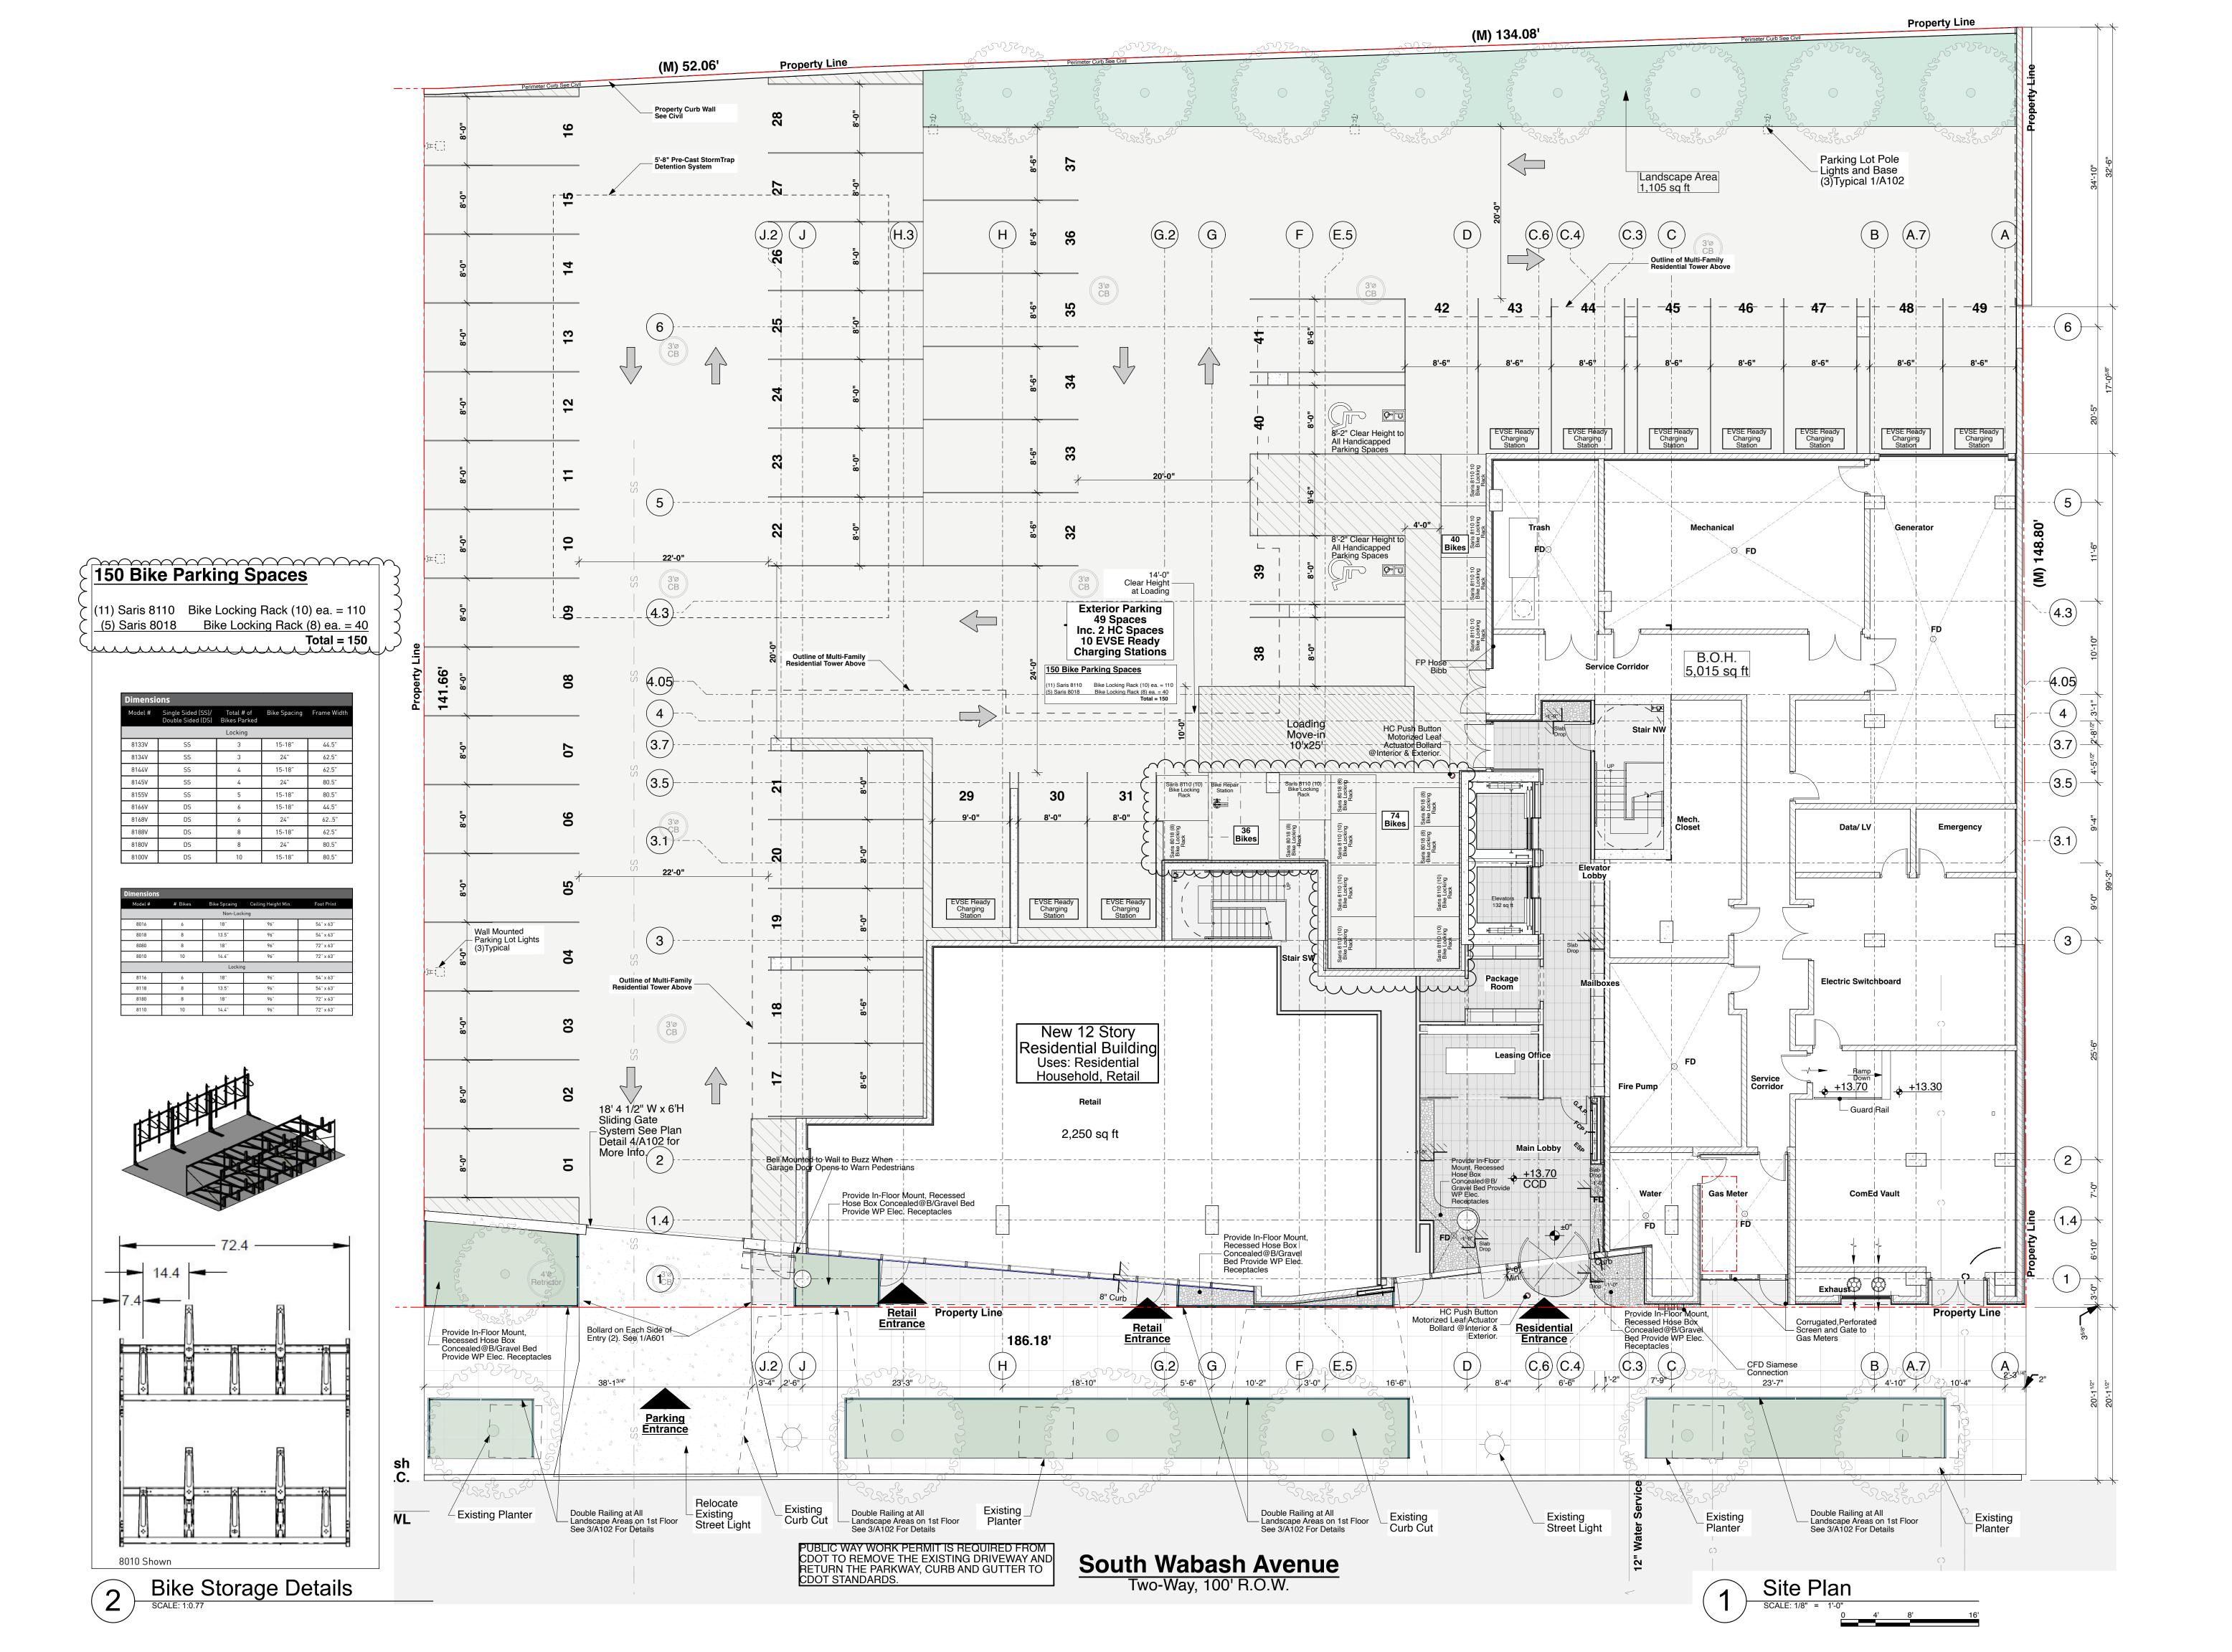



1630 S. Wabash 1630 S. Wabash Ave. Chicago,IL 60616 1630 S. Wabash Development Corp.

	date	description
	06.14.22	Zoning Review
	07.11.22	Issue for Foundation
	08.03.22	Issue For Piles
	09.01.22	Issue For Building Permi
1	12.11.23	Issue For Revised Permi

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orientation	
project number	222820
scale	As Noted
date	2/7/24
sheet title	Site Plar
sheet number	

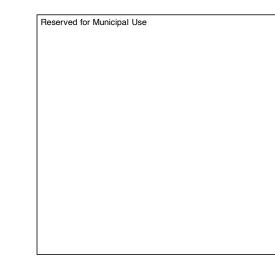A101